


ADA SITE UPGRADES BUILDING 6 STEWART CAMPUS SWPD PROJECT NO. 21-S02-(4)


DESIGN DEVELOPMENT SUBMITTAL 5500 Snyder Avenue, Carson City, Nevada APN: 00924119

DRAWING INDEX		DRAWING	DESCRIPTION
		PS.1	PROJECT SHEET, DRAWING INDEX, DESIGN TEAM, VICINITY MAP
		C0.1	GENERAL NOTES, ABBREVIATIONS & LEGEND
	CIVIL	C1.1	DEMOLITION PLAN
		C1.2	DEMOLITION PLAN
		C2.1	SITE-GRADING PLAN

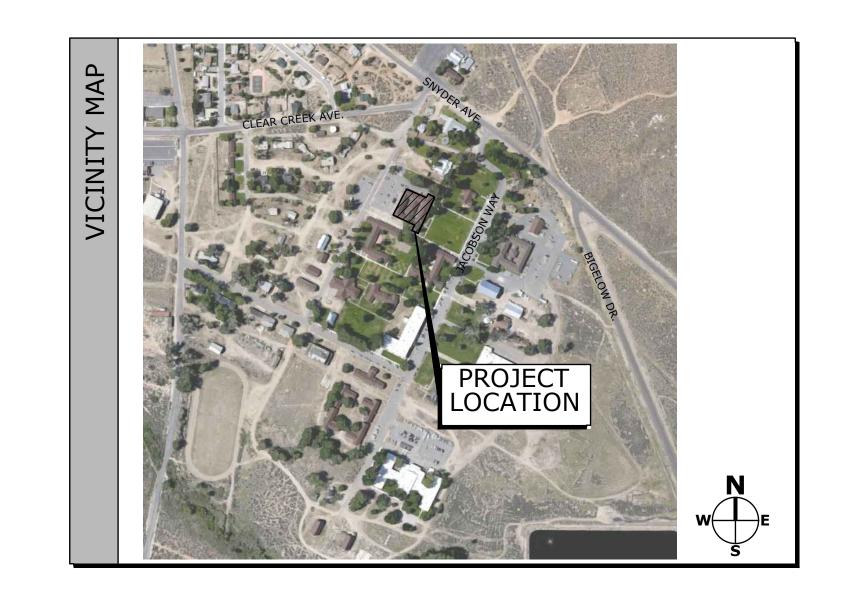

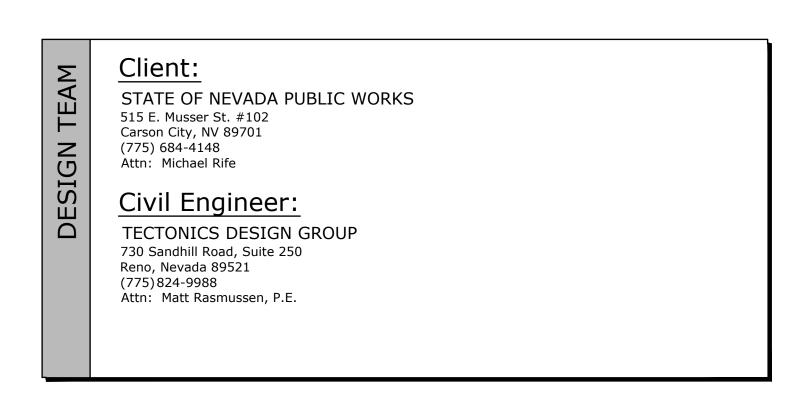

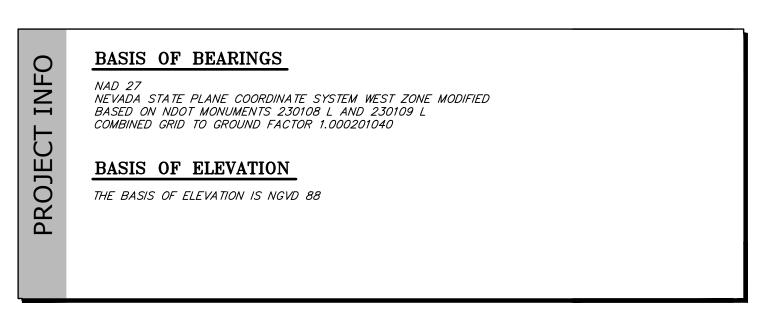

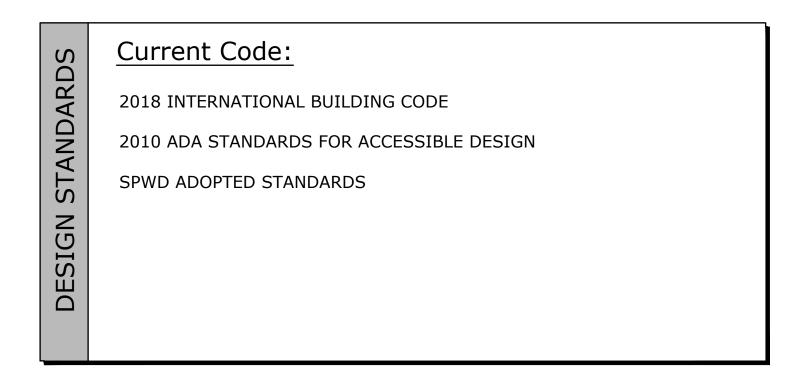

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DRAWN: J.W.R. DESIGNED: J.W.R. CHECKED/STAMPED: MATT K. RASMUSSEN, P.E.

GINE F. S. CIVIL

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00 Snyder Avenue, Carson City, NV 897: ate of Nevada Public Wor. Musser St #102, Carson City, Nevada

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DATE: SUBMITTAL

10/24/23 DESIGN DEVELOPMENT

PROJECT INFORMATION DRAWING INDEX VICINITY MAP DESIGN TEAM

PS.1

GENERAL NOTES

- 1. ALL CONSTRUCTION AND MATERIALS SHALL CONFORM TO THE BOOK "STANDARD SPECIFICATIONS FOR PUBLIC WORKS CONSTRUCTION" (2020 EDITION), AND THE "STANDARD DETAILS FOR PUBLIC WORKS CONSTRUCTION," INCLUDING ANY ADDITIONS OR MODIFICATIONS THAT ARE SET FORTH IN THE DRAWINGS OR SPECIFICATIONS.
- 2. THE CONTRACTOR SHALL ASSUME SOLE AND COMPLETE RESPONSIBILITY FOR JOB SITE CONDITIONS DURING THE COURSE OF CONSTRUCTION FOR THIS PROJECT, INCLUDING SAFETY OF ALL PERSONS AND PROPERTY; THAT THIS REQUIREMENT SHALL APPLY CONTINUOUSLY, AND NOT BE LIMITED TO NORMAL WORKING HOURS; AND THAT THE CONTRACTOR SHALL DEFEND, INDEMNIFY, AND HOLD THE OWNER AND ENGINEER HARMLESS FROM ANY AND ALL LIABILITY, REAL OR ALLEGED, IN CONNECTION WITH THE PERFORMANCE OF WORK ON THIS PROJECT, EXCEPTING FOR LIABILITY ARISING FROM THE SOLE NEGLIGENCE OF THE OWNER OR THE ENGINEER.
- 3. THE CONTRACTOR SHALL BE RESPONSIBLE FOR ALL EXCAVATION AND SHORING PROCEDURES AND CONFORM TO THE LATEST O.S.H.A. REQUIREMENTS.
- 4. THE CONTRACTOR SHALL MAINTAIN AN ON-GOING DUST CONTROL PROGRAM, INCLUDING WATERING OF OPEN AREAS, IN ORDER TO CONFORM WITH THE LATEST FEDERAL, STATE, AND COUNTY AIR POLLUTION REGULATIONS. THE CONTRACTOR SHALL SUBMIT FOR APPROVAL, A DUST CONTROL PLAN TO CARSON CITY DISTRICT HEALTH DEPARTMENT AIR POLLUTION CONTROL DIVISION PRIOR TO COMMENCEMENT OF
- 5. THE CONTRACTOR SHALL BE RESPONSIBLE FOR DAILY REMOVAL OF ALL CONSTRUCTION MATERIALS LOST ON PAVED STREETS, ONSITE OR OFFSITE. AT THE CLOSE OF EACH DAY THE CONTRACTOR SHALL LEAVE THE SITE IN A CLEAN AND ORDERLY FASHION. ALL DEBRIS SHALL BE REMOVED FROM THE SITE OR PLACED IN A GARBAGE RECEPTACLE.
- 6. THE CONTRACTOR SHALL PURSUE THE WORK IN A CONTINUOUS AND DILIGENT MANNER, CONFORMING TO ALL THE PERTINENT SAFETY REGULATIONS, TO INSURE A TIMELY COMPLETION OF THE PROJECT.
- 7. THE CONTRACTOR SHALL NOTIFY THE DESIGN PROFESSIONAL, ALL GOVERNING AGENCIES HAVING JURISDICTION OVER THE WORK, UTILITY COMPANIES, TELEPHONE COMPANIES, CABLE TELEVISION COMPANIES. AND ANY OTHER ENTITY IMPACTED BY THE WORK 48 HOURS PRIOR TO BEGINNING CONSTRUCTION. THE CONTRACTOR SHALL GIVE 24 HOURS PRIOR NOTICE FOR ALL CONSTRUCTION STAKING AND INSPECTIONS REQUIRED DURING CONSTRUCTION.
- 8. ALL AREAS DISTURBED AND LEFT UNDEVELOPED FOR A PERIOD OF MORE THAN 30 DAYS SHALL BE STABILIZED BY THE APPLICATION OF AN APPROVED DUST PALLIATIVE AT NO EXPENSE TO THE OWNER.
- 9. THE CONTRACTOR SHALL OBTAIN AND PAY ALL FEES REQUIRED TO SECURE ANY AND ALL PERMITS NECESSARY TO PERFORM WORK WITHIN THE PUBLIC RIGHT-OF WAY.
- 10. ALL UTILITY LOCATIONS, SIZES, AND DESCRIPTIONS AS SHOWN ARE FROM SURFACE OBSERVATIONS USED IN CONJUNCTION WITH REFERENCE MAPS, DRAWINGS, AND VERBAL STATEMENTS SUPPLIED BY UTILITY COMPANIES. AND MAY NOT BE WHOLLY ACCURATE OR RELIABLE. IT IS THE CONTRACTOR'S RESPONSIBILITY TO VERIFY ALL UTILITIES IN THE FIELD EITHER BY ACTUAL POTHOLING OR VISUALLY, AND NOTIFY THE ENGINEER OF ANY DISCREPANCIES. THE CONTRACTOR SHALL NOTIFY ALL UTILITY COMPANIES WHICH MAY BE AFFECTED BY THE WORK TO OBTAIN ASSISTANCE IN THE LOCATION OF EXISTING MAINS AND SERVICE CONNECTIONS. THE CONTRACTOR SHALL ALSO CALL U.S.A. (1-800-227-2600) PRIOR TO BEGINNING WORK.
- 11. THE CONTRACTOR SHALL BE RESPONSIBLE FOR ALL CONSTRUCTION SIGNING, BARRICADES AND TRAFFIC DELINEATION TO CONFORM TO THE STATE OF NEVADA, DEPARTMENT OF TRANSPORTATION, "NEVADA WORK ZONE TRAFFIC CONTROL MANUAL", AND THE MANUAL FOR UNIFORM TRAFFIC CONTROL
- 12. THE WORK IN THIS CONTRACT INCLUDES ALL ONSITE AND OFFSITE WORK SHOWN ON THESE DRAWINGS, DESCRIBED IN THE SPECIFICATIONS, OR REASONABLY IMPLIED.
- 13. SHOULD ANY PREHISTORIC OR HISTORIC REMAINS/ARTIFACTS BE DISCOVERED DURING CONSTRUCTION, WORK SHALL TEMPORARILY BE HALTED AT THE SPECIFIC SITE AND THE CONTRACTOR SHALL NOTIFY THE DEPARTMENT OF CONSERVATION AND NATURAL RESOURCES, DIVISION OF HISTORIC PRESERVATION AND ARCHEOLOGY FOR THEIR INVESTIGATION OF THE DISCOVERY. THE PERIOD OF TEMPORARY DELAY SHALL BE LIMITED TO A MAXIMUM OF TWO WORKING DAYS FROM THE DATE OF NOTIFICATION.
- 14. ALL DIMENSIONS AND DISTANCES ARE TO FRONT FACE OF CURB, CURB RETURN, FACE OF BUILDING, FACE OF WALL, FLOW LINE, PROPERTY LINE, CENTER OF STRIPING, CENTER LINE OF PIPE OR MANHOLE, OR END OF IMPROVEMENTS.
- 15. THE CONTRACTOR SHALL PROTECT FROM DAMAGE EXISTING IMPROVEMENTS ON AND AROUND THE SITE INCLUDING, BUT NOT LIMITED TO, PAVEMENT, CURB & GUTTER, SIDEWALK, LANDSCAPING, SIGNAGE, STORM & SANITARY SEWERS, UTILITIES, TELEPHONE, AND CABLE TELEVISION. THE CONTRACTOR SHALL ASSUME SOLE RESPONSIBILITY FOR THE REPAIR AND/OR REPLACEMENT OF ANY IMPROVEMENTS (NEW OR EXISTING) DAMAGED THROUGHOUT THE COURSE OF CONSTRUCTION, EITHER AS A DIRECT RESULT OF HIS ACTIVITIES OR HIS FAILURE TO ADEQUATELY PROTECT THE IMPROVEMENT
- 16. THE CONTRACTOR SHALL UPON COMPLETION OF THE PROJECT, PREPARE AND SUBMIT TO THE OWNER OR HIS REPRESENTATIVE, RECORD DRAWINGS INDICATING BY DIMENSION AND DESCRIPTION ANY FACILITY CONSTRUCTED CONTRARY TO THAT SHOWN ON THE DRAWINGS OR DESCRIBED IN THE
- 17. PRIOR TO THEIR INCORPORATION INTO THE WORK, THE CONTRACTOR SHALL SUBMIT FOR THE ENGINEER'S APPROVAL, SHOP DRAWINGS AND MATERIAL SPECIFICATIONS FOR ALL MATERIALS TO BE USED ON THE PROJECT TO INCLUDE, BUT NOT BE LIMITED TO, ASPHALTIC CONCRETE AND PORTLAND CEMENT CONCRETE MIX DESIGN, AGGREGATE BASE QUALIFICATIONS, PIPE BEDDING, SELECT BACKFILL, PRECAST CONCRETE, CAST IRON GRATES AND COVERS, PIPING, FENCING, AND SIGNS.
- 18. THE CONTRACTOR SHALL AT ALL TIMES, PROVIDE AND MAINTAIN EMERGENCY ACCESS TO THE PROJECT SITE IN ACCORDANCE WITH THE REQUIREMENTS OF THE FIRE PROTECTION AGENCY HAVING JURISDICTION OVER THE PROJECT SITE.
- 19. ALL QUANTITIES SHOWN ON THE DRAWINGS ARE APPROXIMATE AND USED ONLY FOR PERMIT AND BOND PURPOSES ONLY. THEY SHALL NOT BE USED IN ANY WAY FOR BIDDING OR CONSTRUCTION PURPOSES. IT SHALL BE THE CONTRACTOR'S RESPONSIBILITY TO MAKE HIS OWN QUANTITY ESTIMATES FOR BIDDING AND CONSTRUCTION PURPOSES.
- 20. INSPECTION REQUIREMENTS SHALL BE IN ACCORDANCE WITH THE STANDARD SPECIFICATIONS.
- 21. THE CONTRACTOR SHALL SUBMIT A SCHEDULE OF EVENTS TO THE ENGINEER AND UPDATE IT EVERY TWO WEEKS, OR SUSTAIN WORK UNTIL IT IS COMPLETED, WITH NO TIME DELAYS IN THE CONTRACT PERIOD. THE SCHEDULE IS FOR THE OWNER AND HIS COORDINATION OF THE OVERALL OPERATION OF THE CONSTRUCTION. THE CONTRACTOR SHALL IN NO WAY IMPEDE THE OVERALL PERFORMANCE OF THE OWNER'S OPERATIONS.
- 22. ALL TRAFFIC CONTROL AND BARRICADING WITHIN THE CARSON CITY RIGHT-OF-WAY SHALL CONFORM TO SECTION 100.33, 332.04 AND 332.05 OF THE STANDARD SPECIFICATIONS, PART VI OF THE MANUAL ON UNIFORM TRAFFIC CONTROL DEVICES, LATEST EDITION, AND THE UNR T2 CENTER, TEMPORARY TRAFFIC CONTROL GUIDELINES LATEST EDITION. A TRAFFIC CONTROL PLAN MUST BE SUBMITTED AND APPROVED BY THE CARSON CITY ENGINEERING DIVISION PRIOR TO ANY STREET CLOSURES.
- 23. THE CONTRACTOR SHALL CALL UNDERGROUND SERVICE ALERT "CALL BEFORE YOU DIG" (811) OR (1-800-227-2600) AT LEAST TWO (2) WORKING DAYS PRIOR TO START OF CONSTRUCTION AND COMPLY WITH THE REQUIREMENTS OF NRS AND NAC 455 THROUGHOUT THE COURSE OF THE WORK.
- 24. THE CONTRACTOR SHALL CALL THE CARSON CITY ENGINEERING DIVISION (887-2300) TWO (2) WORKING DAYS PRIOR TO THE START OF CONSTRUCTION. THE CONTRACTOR SHALL CALL ONE (1) WORKING DAY PRIOR TO REQUIRED INSPECTIONS AND TESTING. THE REQUIRED INSPECTIONS AND TESTING ARE LISTED ON THE INSPECTION RECORD ISSUED WITH EACH PERMIT. THE CONTRACTOR MUST HAVE THE PERMIT NUMBER AND THE DESCRIPTION LISTED ON THE INSPECTION RECORD TO SCHEDULE REQUIRED INSPECTIONS AND TESTING. FOR CITY CONTRACTED PROJECTS, THE CONTRACTOR SHALL SCHEDULE INSPECTIONS PER THE CONTRACT DOCUMENTS.
- 25. MODIFICATIONS TO THE APPROVED PLANS REQUIRES REVIEW AND APPROVAL BY THE CARSON CITY ENGINEERING DIVISION. WORK PERFORMED WITHOUT WRITTEN APPROVAL BY CARSON CITY ENGINEERING WILL REQUIRE REMOVAL AT THE CONTRACTORS EXPENSE.
- 26. THE APPROVED PLAN, PERMIT AND INSPECTION RECORD MUST BE ON THE JOB SITE AT ALL TIMES.
- 27. PLAN APPROVAL FOR SEWER AND WATER CONSTRUCTION SHALL EXPIRE ONE YEAR FROM DATE OF APPROVAL UNLESS CONSTRUCTION HAS BEEN INITIATED. (CCMC 12.06.180F, 12.01.140D)
- 28. THE CONTRACTOR WILL BE SOLELY AND COMPLETELY RESPONSIBLE FOR ACQUIRING A STORMWATER DISCHARGE PERMIT FROM THE NEVADA DIVISION OF ENVIRONMENTAL PROTECTION INCLUDING DEVELOPING, SUBMITTING AND IMPLEMENTING A STORM WATER POLLUTION PREVENTION PLAN (SWPPP). THE CONTRACTOR SHALL DEVELOP, PLACE AND MAINTAIN STORM WATER PROTECTION DEVICES IN COMPLIANCE WITH THE NEVADA CONTRACTORS FIELD GUIDE FOR CONSTRUCTION SITE BEST MANAGEMENT PRACTICES (JUNE 2008).

DEMOLITION NOTES:


- 1. THE CONTRACTOR MAY SALVAGE ITEMS NOT SPECIFICALLY DESIGNATED AS NON-SALVAGEABLE WITH WRITTEN PERMISSION FROM THE ENGINEER. THE NON-SALVAGEABLE MATERIALS SHALL BE DISPOSED OF AT THE APPROPRIATE LOCATIONS.
- 2. THE CONTRACTOR SHALL BE RESPONSIBLE FOR THE PROPER OFF-SITE DISPOSAL OF MATERIALS TO BE REMOVED AND DISPOSED OF. THE CONTRACTOR SHALL COORDINATE WITH THE ENGINEER, AREAS TO BE USED FOR THE TEMPORARY STOCKPILING OF MATERIALS TO BE REMOVED.
- 3. THE CONTRACTOR SHALL WET-DOWN AND TARP EVERY TRUCK LOADS LEAVING THE SITE FOR A DISPOSAL AREA. THIS PROCEDURE IS CRITICAL TO THE DUST ABATEMENT PLAN AND WILL BE STRICTLY ENFORCED.
- 4. THE CONTRACTOR SHALL APPLY AND PAY FOR ALL PERMITS REQUIRED FOR THIS PROJECT, UNLESS SPECIFIED OTHERWISE
- 5. IF STRUCTURE REMOVAL CREATES SIGNIFICANT DEPRESSIONS, THE CONTRACTOR SHALL ROUND OFF THE SIDES TO 3:1 SLOPE, AND COMPACT TO 85% M.D.D.
- 6. ALL SAWCUT LINES SHALL BE NEATLY DONE, PARALLEL AND PERPENDICULAR TO EXISTING IMPROVEMENTS. SAWCUT LINES SHALL BE ADJUSTED TO REASONABLY INCORPORATE AREAS OF DAMAGED CURB, GUTTER, SIDEWALK, AND PAVEMENT.
- 7. REMOVE AND DISPOSE OF ANY DEBRIS THAT IS WITHIN THE CONSTRUCTION LIMITS AND IS NOT SPECIFICALLY CALLED OUT.

- 1. REFERENCE LANDSCAPING PLANS FOR MOUNDING, PLANTING, AND IRRIGATION CONSTRUCTION.
- 2. ALL P.C.C. CURB, GUTTER, SIDEWALK, AND SLOPE PAVING SHALL BE CLASS AA OR DA CONCRETE (4000 PSI), WITH BROOM FINISH, UNLESS OTHERWISE INDICATED.
- 3. CONCRETE SIDEWALKS SHALL HAVE 1/2" EXPANSION JOINTS AT ALL POINTS ABUTTING BUILDINGS AND STRUCTURES, EVERY 30 FOOT INTERVAL, AT ALL SIDEWALK RETURNS, AND OPPOSITE EXPANSION JOINTS IN ADJACENT CURB. EXPANSION JOINTS ABUTTING BUILDINGS AND STRUCTURES SHALL HAVE SILICONE APPLIED TO THE JOINT TO PREVENT WATER INTRUSION. WEAKENED PLANE JOINTS SHALL BE LOCATED AT INTERVALS NOT EXCEEDING 1.2 TIMES THE WIDTH AND NO MORE FREQUENTLY THAN 0.8 TIMES THE WIDTH. IN NO CASE SHALL REGULAR INTERVALS OF WEAKENED PLANE JOINTS IN EITHER DIRECTION EXCEED 10 FEET.
- 4. IN ALL AREAS WHERE NEW A.C. PAVEMENT OR PATCH IS TO MATCH EXISTING PAVEMENT, THE CONTRACTOR SHALL SAWCUT AND REMOVE THE EXISTING PAVEMENT 24" FROM SUCH IMPROVEMENTS OR AS INDICATED ON THE PLANS. NEW PAVEMENT OR PAVEMENT PATCH SHALL CONFORM TO THE EXISTING PAVEMENT AT THIS POINT AND TRANSITION SMOOTHLY TO THE NEW IMPROVEMENTS.
- 5. THE CONTRACTOR SHALL MAINTAIN FIRE ACCESS TO ALL THE BUILDINGS TO THE SATISFACTION OF THE CITY'S FIRE DEPARTMENT.
- 6. ALL DIMENSIONS AND DISTANCES ARE TO FRONT FACE OF CURB, CURB RETURNS, FACE OF BUILDINGS, FACE OF WALL, FLOWLINE, PROPERTY LINE, CENTER OF STRIPING, CENTERLINE OF PIPE OR MANHOLES, CENTER OF FENCING, OR END OF IMPROVEMENTS.
- 7. ALL QUANTITIES SHOWN ON THESE DRAWINGS ARE APPROXIMATE AND SHOULD BE USED FOR PERMIT PURPOSES ONLY. THEY SHALL NOT BE USED IN ANY WAY FOR BIDDING PURPOSES OR CONSTRUCTION PURPOSES. IT SHALL BE THE CONTRACTOR'S RESPONSIBILITY TO MAKE HIS OWN QUANTITY ESTIMATES FOR BIDDING AND CONSTRUCTION PURPOSES

MIDDLE ORDINATE ASPHALTIC CONCRETE _MILLION GALLONS PER DAY ASBESTOS CONCRETE PIPE MANHOLE BUILDING CORNER MID-ORDINATE VERTICAL CURVE BOUNDARY MONITORING WELL ___BEGIN VERTICAL CURVE NOT IN CONTRACT BACK OF SIDEWALK NOT TO SCALE BOTTOM OF WALL ORIGINAL GROUND RUNOFF COEFFICIENT OVERHEAD CORNER CONCRETE OFFSET LINE ___CURB AND GUTTER PAD FI EVATION __CATCH BASIN POINT OF CURVATURE CUBIC FEET PER SECOND POINT OF INTERSECTION ___CENTERLINE PLASTIC IRRIGATION PIPE ___CHORD POST INDICATOR VALVE ___CAST IRON PROPERTY LINE CORRUGATED METAL PIPE
CLEANOUT POINT OF TANGENCY POINT OF REVERSE CURVATURE CONC. CONCRETE __POLYVINYL CHLORIDE PIPE CONST ___CONSTRUCT DISCHARGE RATE CONCRETE PIPE CPLG___COUPLING RADIUS RADIAL __CURB RETURN REBAR REINFORCING BARS __DELTA REINFORCED CONCRETE BOX DETECTOR CHECK VALVE __REINFORCED CONCRETE PIPE DROP INLET OR DUCTILE IRON REFERENCE DIAMETER RETURN DETAIL ELECTRICAL RAPID INFILTRATION BASIN RIM ELEVATION EXISTING
ELEVATION OR ELBOW RIGHT OF WAY RIGHT ___END CURVE SLOPE EDGE OF PAVEMENT STORM DRAIN ___EDGE OF SAWCUT LINE SQUARE FOOT END VERTICAL CURVE SHEET FLARED END SECTION SANITARY SEWER FINISH FLOOR STEEL FRONT FACE OF CURB STATION FRONT FACE OF WALL SIDEWALK FINISH GRADE FIRE HYDRANT TRANSFORMER TELEPHONE FLANGE PIPE CONNECTION FLOW LINE TOP OF BANK TOP BACK OF CURB (EX) ____GROUND TOP OF CURB __GRADE BREAK TIME OF CONCENTRATION GAS METER TOP OF GRATE GPM____GALLONS PER MINUTE _TOE OF SLOPE GAS VALVE TOP OF PAVEMENT ___HORIZONTAL TELEVISION HIGH POINT TOP OF WALL HOUSE SERVICE TYPICAL INTENSITY __VERTICAL CURVE _INVERT ELEVATION VERTICAL IRON PIPE SIZE VERTICAL POINT OF INTERSECTION __IRRIGATION WATER LENGTH WATER METER __LINEAL FEET WATER VALVE LIP OF GUTTER LOW POINT



ABBREVIATIONS

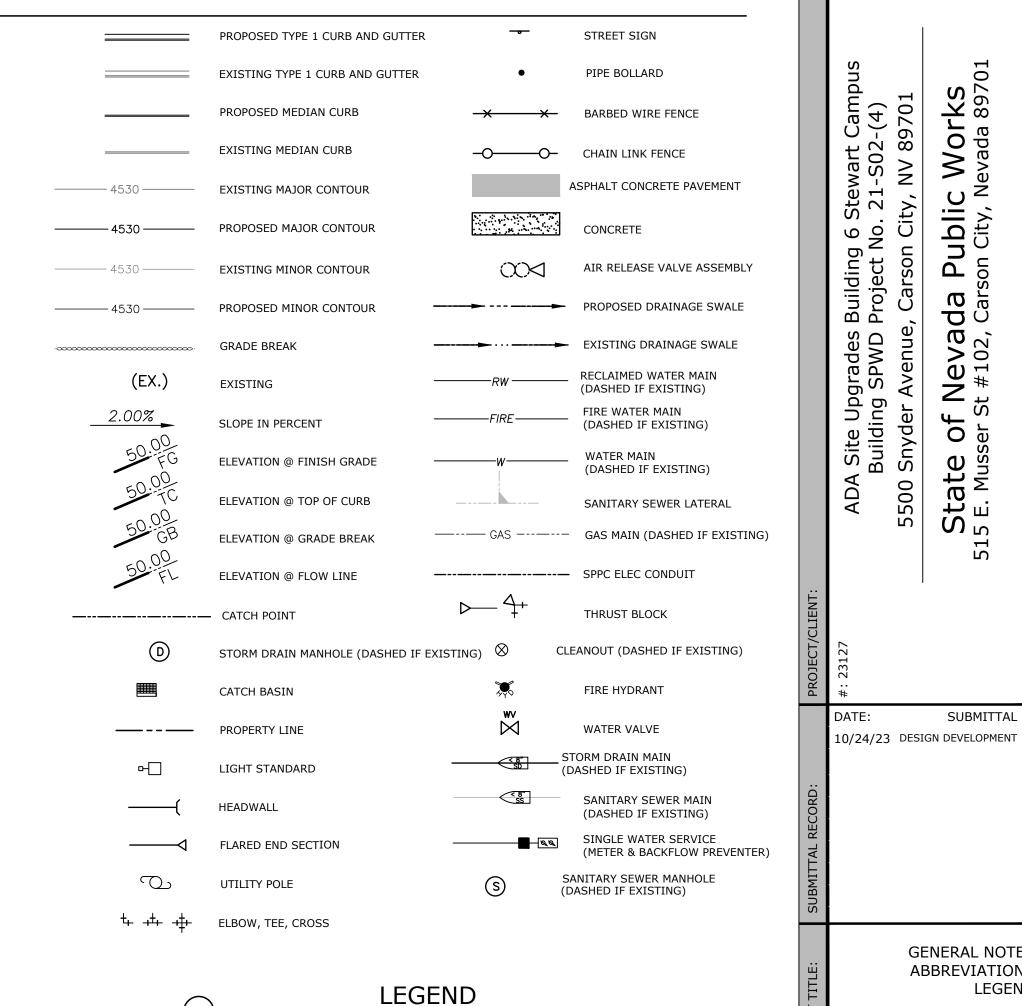

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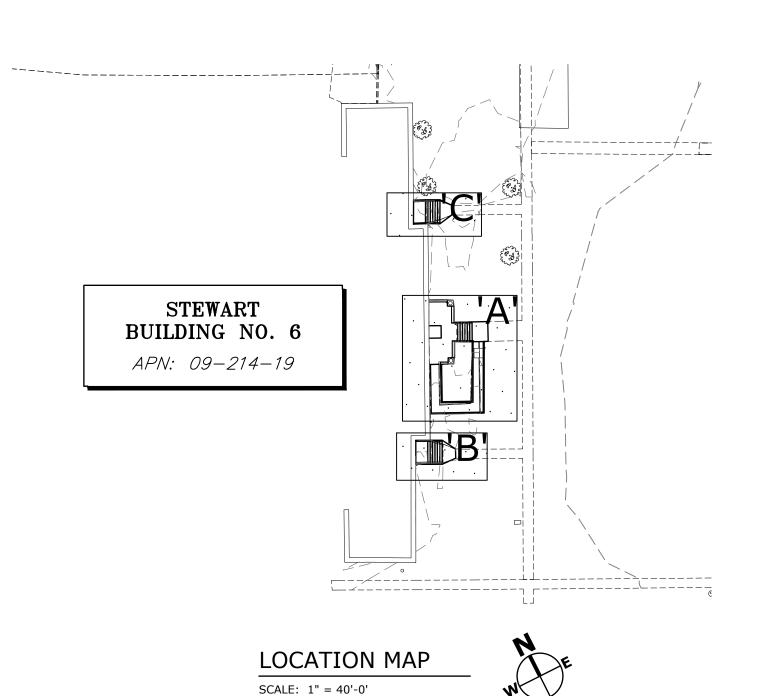
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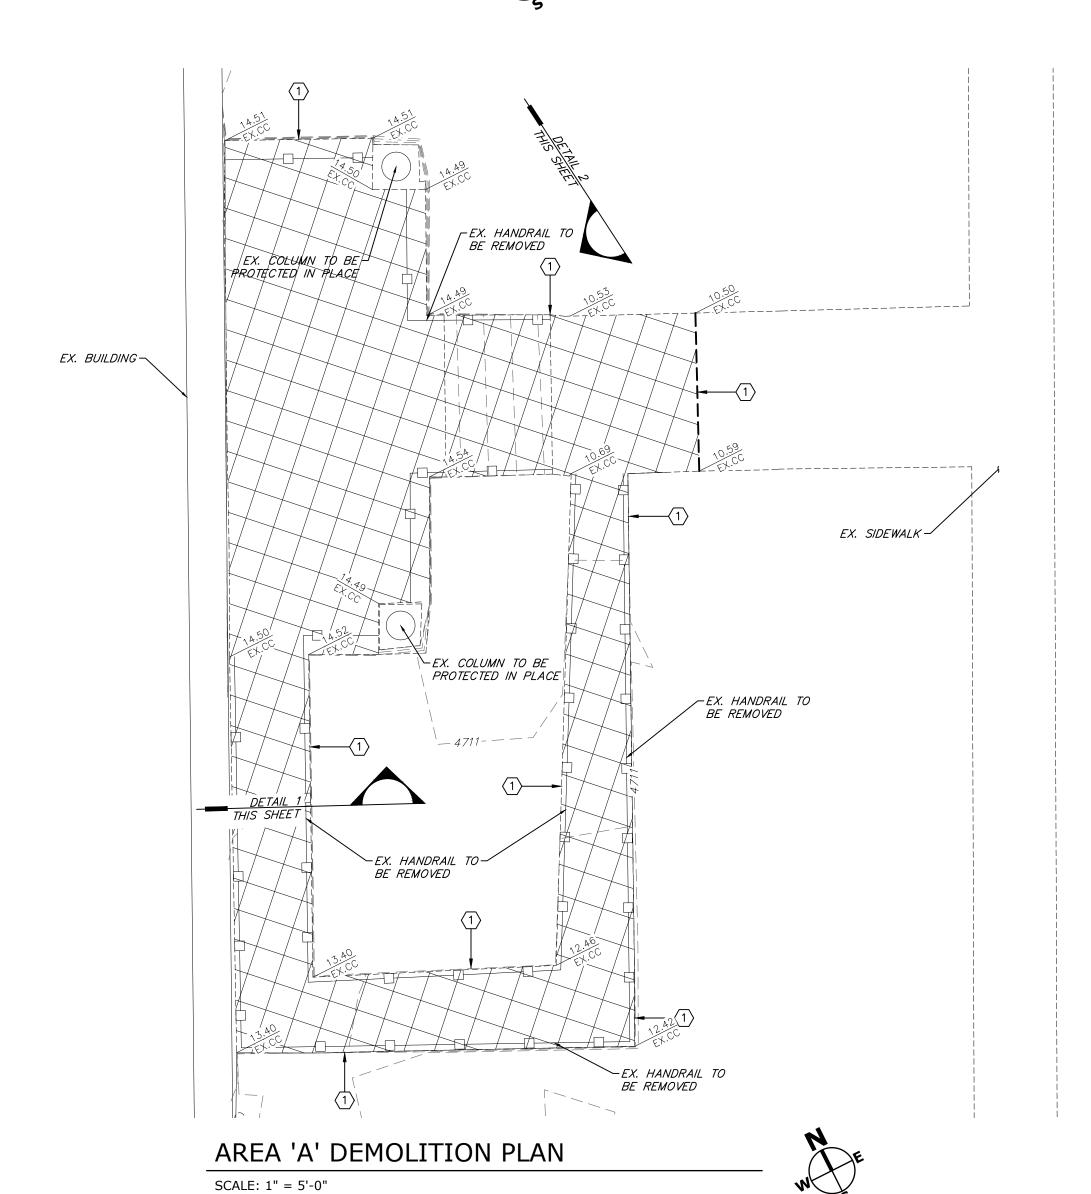
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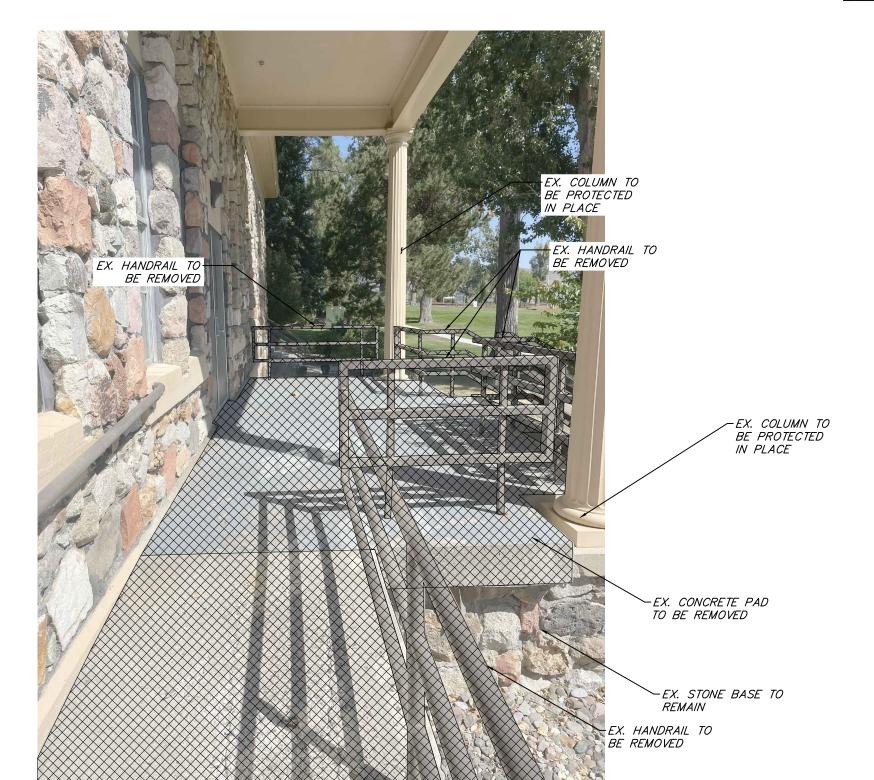
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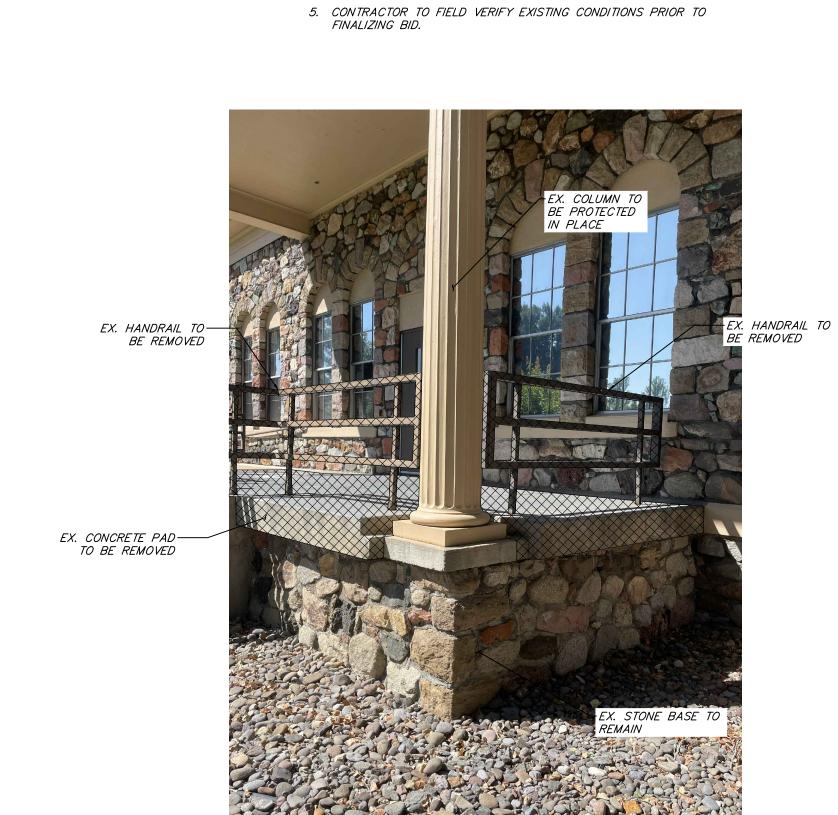
GENERAL NOTES **ABBREVIATIONS** LEGEND







DETAIL 1 SCALE: NTS



CONSTRUCTION NOTES:

1. REFERENCE "GENERAL NOTES" ON SHEET CO.1

2. REFERENCE "ABBREVIATIONS" ON SHEET CO.1


4. ADD 4700 TO ALL FINISHED GRADE OR INVERT ELEVATIONS

3. REFERENCE "LEGEND" ON SHEET CO.1

NOTES:

- EXISTING FACILITIES TO BE REMOVED 1. SAWCUT

DETAIL 2 SCALE: NTS

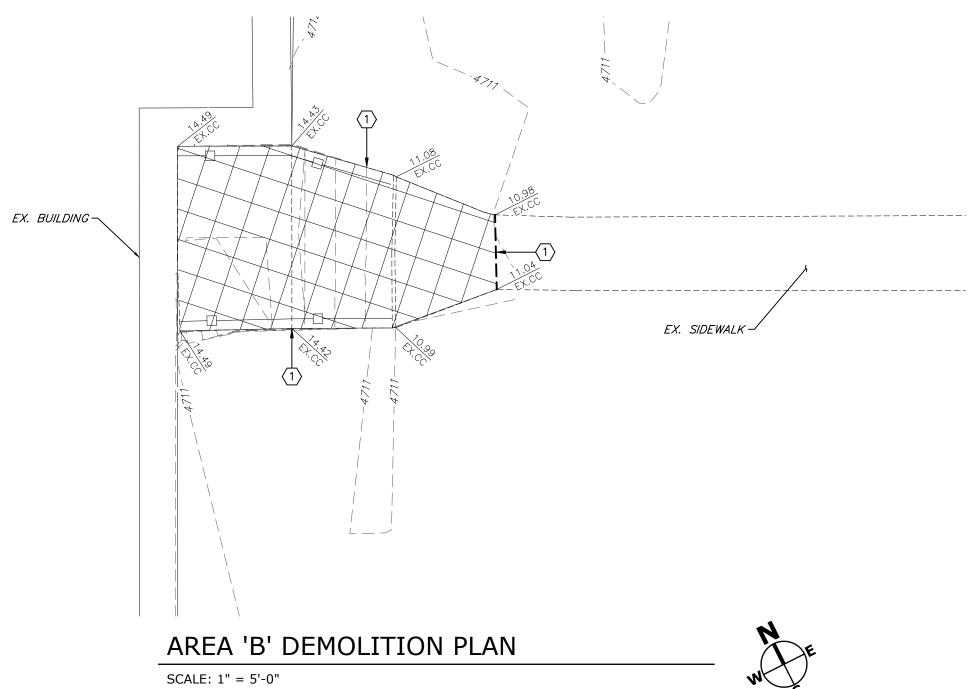

2 DAYS BEFORE YOU DIG CALL USA TOLL FREE 1-800-227-2600


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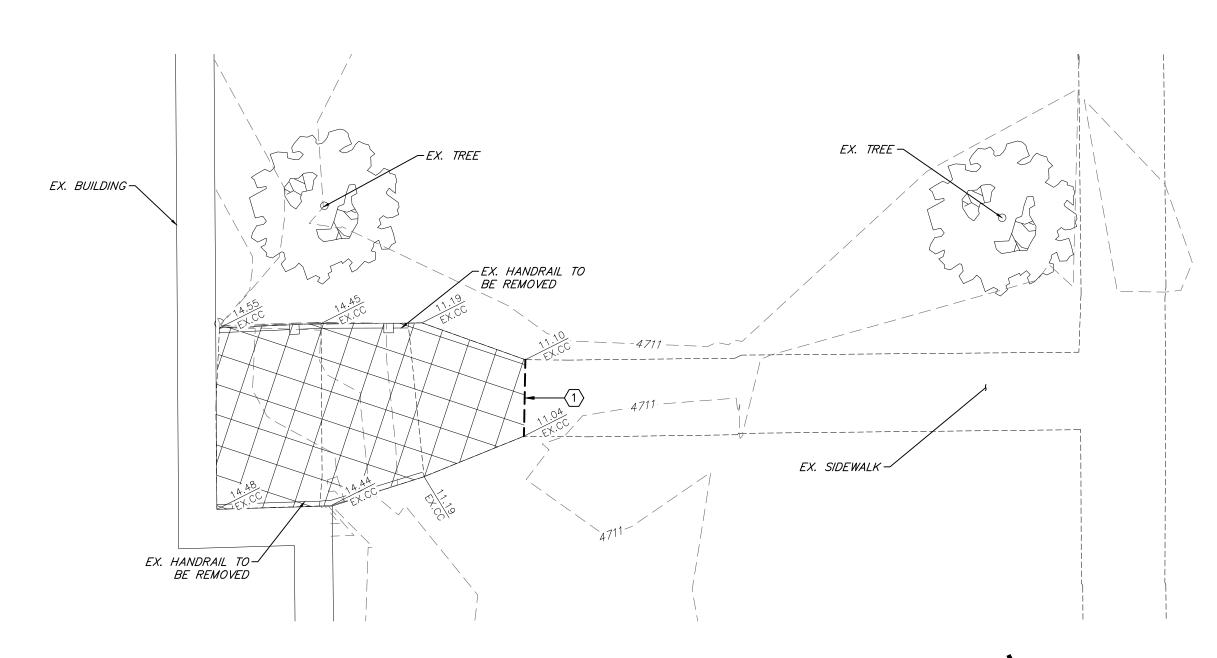
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10/24/23

SUBMITTAL 10/24/23 DESIGN DEVELOPMENT

DEMOLITION PLAN



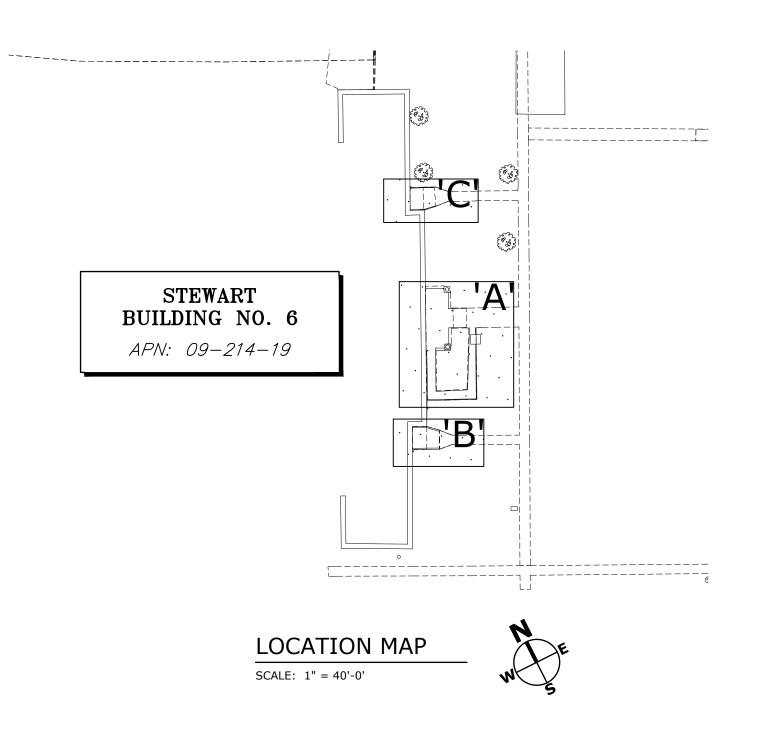

AREA 'C' DEMOLITION PLAN SCALE: 1" = 5'-0"



CONSTRUCTION NOTES:

- 2. REFERENCE "ABBREVIATIONS" ON SHEET CO.1
- 4. ADD 4700 TO ALL FINISHED GRADE OR INVERT ELEVATIONS

- EXISTING FACILITIES TO BE REMOVED

1. SAWCUT

NOTES:

1. REFERENCE "GENERAL NOTES" ON SHEET CO.1

3. REFERENCE "LEGEND" ON SHEET CO.1

5. CONTRACTOR TO FIELD VERIFY EXISTING CONDITIONS PRIOR TO FINALIZING BID.

<u>LEGEND:</u>

2 DAYS BEFORE YOU DIG CALL USA TOLL FREE 1-800-227-2600

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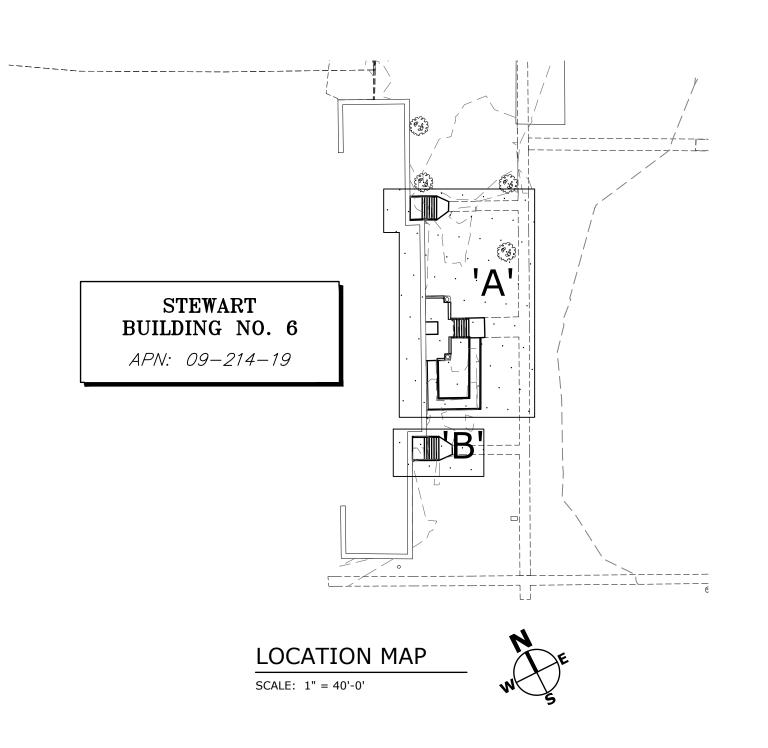
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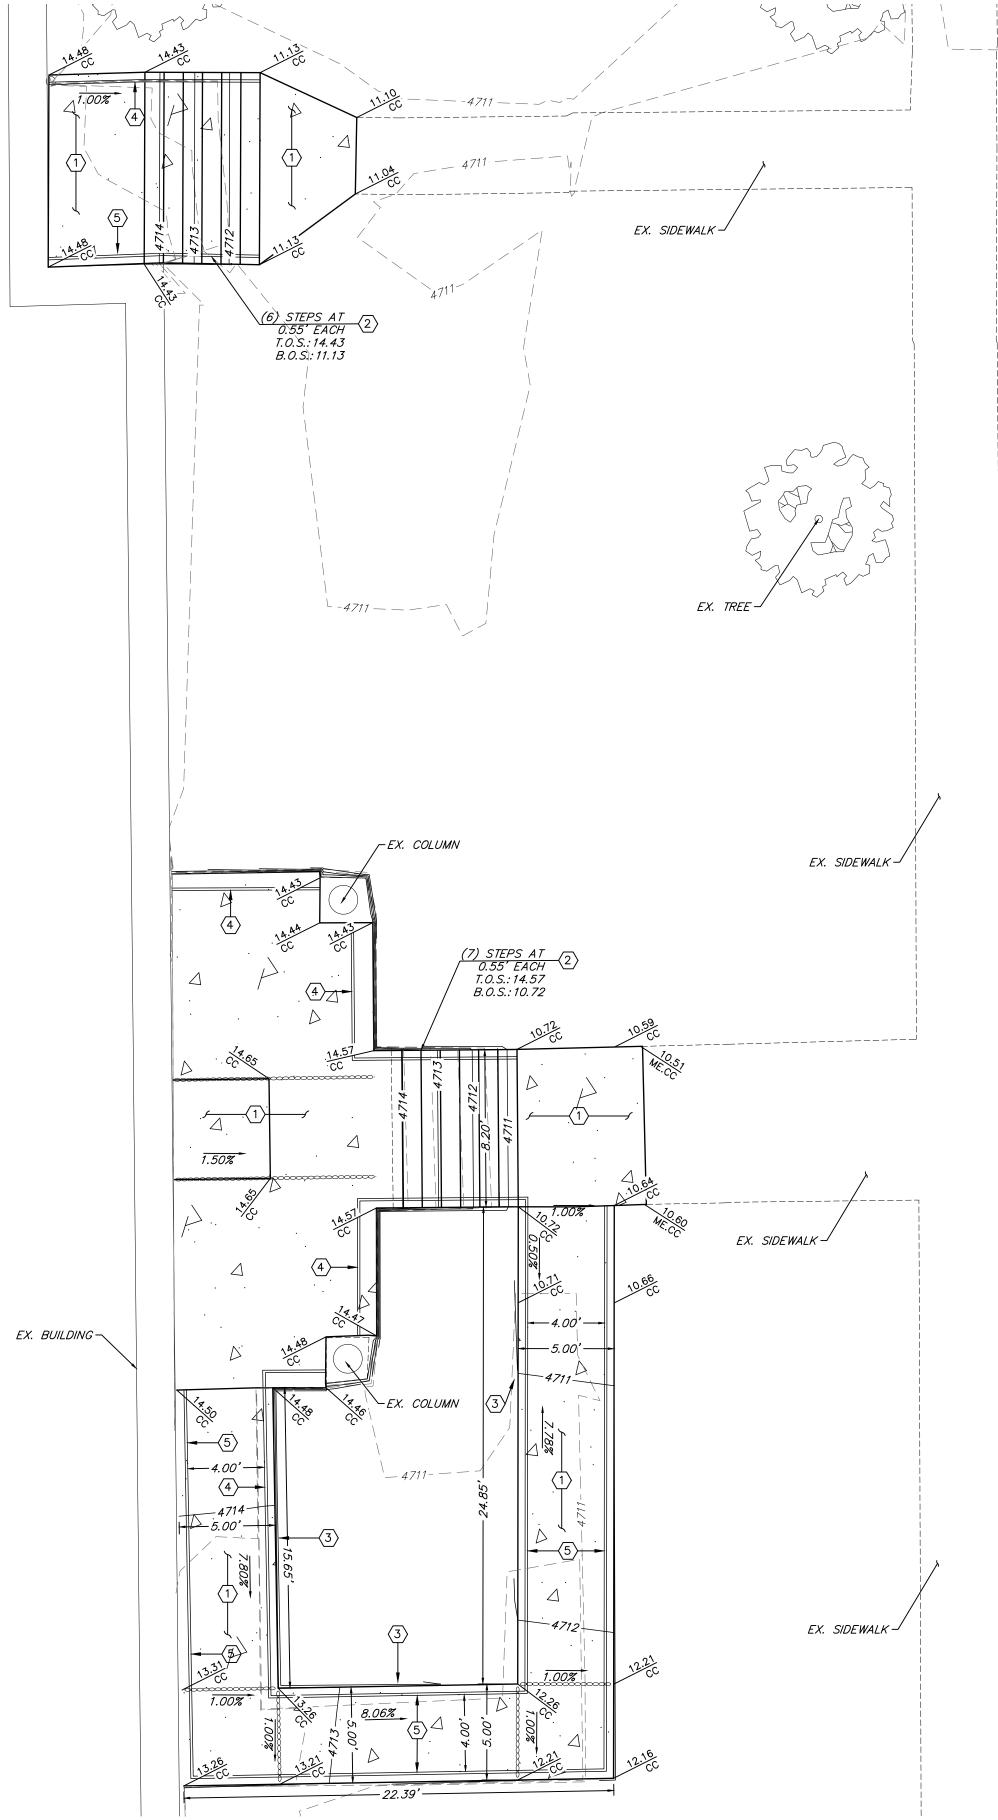
CHECKED/STAMPED: MATT K. RASMUSSEN, P.E.

DRAWN: DESIGNED:

SUBMITTAL 10/24/23 DESIGN DEVELOPMENT

DEMOLITION PLAN







EX. BUILDING —

1.50%

- 1. ALL EXTERIOR CONCRETE EXPOSED TO FREEZING AND THAWING CONDITIONS SHOULD BE RATED AT 4,500 PSI MINIMUM
- 2. REFERENCE "GENERAL NOTES" ON SHEET CO.1
- 3. REFERENCE "ABBREVIATIONS" ON SHEET CO.1
- 4. REFERENCE "LEGEND" ON SHEET CO.1
- 5. ADD 4700 TO ALL FINISHED GRADE OF INVERT ELEVATIONS

(6) STEPS AT (2) 0.55 EACH T.O.S.: 14.42 B.O.S.: 11.12 \$\frac{4}{2}\$

SCALE: 1" = 5'-0"

AREA 'B' SITE/GRADING PLAN

- 6. GENERAL CONTRACTOR TO FIELD VERIFY EXTENT OF ALL PROPOSED GUARDRAILS PRIOR TO FABRICATION.
- CONSTRUCTION NOTES:
- 1. CONSTRUCT TYPICAL SIDEWALK
- 2. CONSTRUCT TYPICAL STAIR & HANDRAIL
- 3. CONSTRUCT ADA RAMP

EX. SIDEWALK —

- 4. CONSTRUCT GUARDRAIL
- 5. CONSTRUCT HANDRAIL

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CHECKED/STAMPED: MATT K. RASMUSSEN, P.E.

DRAWN:

DESIGNED:

10/24/23

J.W.R.

SUBMITTAL 10/24/23 DESIGN DEVELOPMENT

SITE-GRADING PLAN

C2.1

AREA 'A' SITE/GRADING PLAN

SCALE: 1" = 5'-0"



2 DAYS BEFORE YOU DIG CALL USA TOLL FREE 1-800-227-2600